ATTACHMENT B

Project Plans and Materials

[Full Size Plans Available for Review at the Town Offices]

6-UNITS RESIDENTIAL DEVELOPMENT

54 MONO ST., MAMMOTH LAKES, CA

&:	AND	D.O.	DOOR OPENING	I.D.	INSIDE DIAMETER	SQ.	SQUARE
L	ANGLE	DR.	DOOR	INSUL.	INSULATION	S.ST.	STAINLESS STEEL
_ @	AT	DWR.	DRAWER	INT.	INTERIOR	STD.	STANDARD
Q.		D.S.	DOWNSPOUT			STL.	STEEL
	CENTERLINE	DWG.	DRAWING	JT.	JOINT	STOR.	STORAGE
ø	DIAMETER OF ROUND	D 110.	Bititiiiii			STRL.	STRUCTURAL
#	POUND OR NUMBER	E.	EXISTING	KIT.	KITCHEN	SYM.	SYMMETRICAL
(E)	EXISTING	EA.	EACH				
		E.J.	EXPANSION JOINT	LAMINATE	LAM.		
(R)	RELOCATED	EL.	ELEVATION	LAV.	LAVATORY	T.B.S.	TO BE SPECIFIED
(N)	NEW	ELEC.	ELECTRICAL	LT.	LIGHT	TRD.	TREAD
		E.P.	ELECTRICAL			T.B.	TOWEL BAR
		L.I .	PANELBOARD	MANU.	MANUFACTURER	T.C.	TOP OF CURB
A.F.F.	ABOVE FINISH FLOOR	EQ.	EQUAL	MAX.	MAXIMUM	TEL.	TELEPHONE
A.D.	AREA DRAIN	EQPT.	EQUIPMENT	M.C.	MEDICINE CABINET	TER.	TERRAZZO
				MECH.	MECHANICAL	T.& G.	TONGUE & GROO
ADJ.	ADJUSTABLE	EXST.	EXISTING			THK.	THICK
AGGR.	AGGREGATE	EXP.	EXPANSION	MEMB.	MEMBRANE	T.P.	TOP OF PAVEMEN
AL.	ALUMINUM	EXT.	EXTERIOR	MET. MFR.	METAL MANUFACTURER	•••	
APPROX.	APPROXIMATE	F.F	FLOOR FINISH		MINIMUM		
ARCH.	ARCHITECTURAL	FDN.	FOUNDATION	MIN.	MINIMOM	MIR.	MIRROR
ASB.	ASBESTOS	FIN.	FINISH	PL.	PLATE	MISC.	MISCELLANEOUS
ASPH.	ASPHALT	FL.	FLOOR	P.LAM.	PLASTIC LAMINATE	M.O.	MASONRY OPENIN
				PLAS.	PLASTER	MTD.	MOUNTED
BD.	BOARD	FLASH'G	FLASHING	PLYWD.	PLYWOOD	MUL.	MULLION
ВІТИМ.	BITUMINOUS	FLUOR.	FLUORESCENT	PR.	PAIR		
BLDG.	BUILDING	F.O.C.	FACE OF CONCRETE	PROV'D	PROVIDED	N.	NEW
BLKG.	BLOCKING	F.O.F.	FACE OF FINISH	PT.		N.I.C.	NOT IN CONTRAC
ВΜ.	BEAM	1.0.1.	TAGE OF TIMISH	PI.	POINT	NO./#	NUMBER
B.0.H.	BACK OF HOUSE	F.0.S.	FACE OF STUDS	PTN.	PARTITION	NOM.	NOMINAL
BOT.	BOTTOM	FPRF.	FIREPROOF			N.T.S.	NOT TO SCALE
		F.S.	FLOOR SINK	Q.T.	QUARRY TILE		
CAB.	CABINET	FT.	FOOT OR FEET	QSR	QUICK SERVE	O.A.	OVERALL
CEM.	CEMENT	FTG.	FOOTING		RESTAURANT	OBS.	OBSCURE
CER.	CERAMIC	FURR.	FURRING	R/RAD.	RADIUS	0.C.	ON CENTER
C.I.	CAST IRON			R.D.	ROOF DRAIN	O.D.	OUTSIDE DIAMETE
CLG.	CEILING	FUT.	FUTURE	REF.		OFF.	OFFICE
CLKG.	CAULKING				REFERENCE	OPNG.	OPENING
CLO.	CLOSET	G.A.	GAUGE	REFR.	REFRIGERATOR	OPP.	OPPOSITE
CLR.	CLEAR	GALV.	GALVANIZED	RGTR.	REGISTER		
C.O.	CASED OPENING	GL.	GLASS	REINF.	REINFORCED	PLBG.	PLUMBING
COL.	COLUMN	GR.	GRADE	REQ'D	REQUIRED	T.P.D.	TOILET PAPER
CONC.	CONCRETE	GSM	GALVANIZED	RESIL.	RESILIENT		DISPENSER
CONN.	CONNECTION		SHEET METAL	RM.	ROOM	T.V.	TELEVISION
CONSTR.	CONSTRUCTION	GYP.	GYPSUM	R.O.	ROUGH OPENING	T.W.	TOP OF WALL
CONT.	CONTINUOUS	GYP. BD.	GYPSUM BOARD	RWD.	REDWOOD	TYP.	TYPICAL
CTSK.	COUNTERSUNK			R.W.L.	RAIN WATER LEADER	UNF.	UNFINISHED
CNTR.	COUNTER	H.B.	HOSE BIBB			U.O.N.	UNLESS
CTR.	CENTER	H.C.	HOLLOW CORE	S.C	SOLID CORE		OTHERWISE NOTE
		HCP	HANDICAP	SCHED.	SCHEDULE	VERT	VERTICAL
		HDWD.	HARDWOOD	S.D.	SOAP DISPENSER	W.	WEST
DBL.	DOUBLE	HDWE.	HARDWARE	SECT.	SECTION	w. W/	WITH
DEPT.	DEPARTMENT	H.M.	HOLLOW METAL	SH.	SHELF	w, W.C.	WATER CLOSET
DET.	DETAIL	HORIZ.	HORIZONTAL	SHR.	SHOWER	W.C. WD.	WOOD WOOD
DIA.	DIAMETER	HR.		SHT.			
			HOUR	эп I.	SHEET	W/0	WITHOUT
DIM.	DIMENSION	LCT	LEICHT	CIM	CIMIL A D	MAC	WATERDROOF
DIM. DISP.	DIMENSION DISPENSER	HGT.	HEIGHT	SIM. SL.	SIMILAR SLOPE	WP. WSCT.	WATERPROOF WAINSCOT

Project Directory

OWNER: MR. BIPIN MORARI F: BIPIN@JAYBHARAT.COM

ARCHITECT: PEGASUS ARCHITECTS C.F. LAU, AIA 4300 EDISON AVE., CHINO, CA 91710 TEL.: 909.465.4101

CIVIL ENGINEER: WABER CONSULTANTS, INC. MAHIR WARER 19210 S. VERMONT STE. A115 GARDENA CA 90248 TEL.: 424.344.2464 EXT. 29 F: mwaber@waberconsultants.com LANDSCAPE ARCHITECT: PHIL MAY LANDSCAPE ARCHITECTURE ROSALIO SERNA

215 N. 2ND AVENUE, SUITE C UPLAND, CA 91786

Project Narrative:

HAS A GENTLE SLOPE AND SOME VEGETATIONS.

E: PMAY@PHILMAYDESIGN.COM

BE EMPLOYED AS NEEDED.

OWNER'S EMPLOYEES.

UNIT TYPE

GARAGE

A-2 (1-BED)

B (1-BED)

C (3-BED)

TOTAL

A-1 (1-BED) 326

FROM THE STREET TO ALL ENTRIES.

Area Calculation

758

774

326

1,426 1,426

2,95 2,90

TEL.: (909) 373-1959

THIS PROPOSED 6-UNITS MULTI-FAMILY (3-STORY HEIGHT) RESIDENTIAL DEVELOPMENT IS LOCATED AT 54 MONO STREET, THE TOWN OF MAMMOTH

THE PROJECT IS CALLED FOR 100% DENSITY INCREASE UNDER THE TOWN DENSITY BONUS ORDINANCE SECTION 17.138.050 AS EMPLOYEE HOUSING. THI

SIDE YARDS, PLUS ONE GUEST PARKING REDUCTION AS WELL.

REQUESTED INCENTIVES ARE A REDUCTION OF 20% SETBACKS AT REAR AND

THE EXTERIOR MATERIALS ARE SPLIT-FACED CMU WALL, STUCCO, SLOPED

SHINGLED ROOF AND CEMENT BOARD FINISHES. WINDOWS ARE DUAL GLAZED; ALL PLUMBING FIXTURES ARE PER CODE WITH WATER SAVING SUFFICIENT THE COOLING AND HEATING AREA PROVIDED PER INDIVIDUAL UNIT

NOT AS CENTRAL TYPE. THIS WILL MINIMIZE COOLING OR HEAT LOSS. THE LANDSCAPE IS OF THE CITY'S STANDARD. AN AREA OF SNOW STORAGE AT

THE FRONT YARD IS ALSO PROVIDED, AND ANY ADDITIONAL HAIL-AWAY WILL

THIS DEVELOPMENT HAS A PODIUM FOR THE RESIDENT'S PARKING, AND THE GUEST PARKING AND ADA PARKING ARE PARTIALLY COVERED. AN ADA UNIT

THIS MULTI-EAMILY RESIDENTIAL DEVELOPMENT WILL BE A GOOD ADDITION TO THE HOUSING NEEDED IN THE CITY AND WILL ALSO HELP THE NEEDS OF THE

UNIT COUNT PER FLOOR/TYPE

UNIT S.F

1,084

702

1,548

2.852

STORAGE

(CU.SQ.FT.

915

915

TOTAL S.

1,084

702

1.548

2.852

6,186

IS ACCESSIBLE ON THE GROUND FLOOR. THE SITE IS FULLY ACCESSIBLE

LAKES. THE SURROUNDINGS ARE ALSO RESIDENTIAL DEVELOPMENTS. THE SITE

E: CHAK@PEGASUSARC.COM

LANDSCAPE L-1 TITLE SHEET L-2 PRELIMINARY PRELIMINARY LANDSCAPE PLAN

PHOTOMETRIC
E3.1 SITE PHOTOMETRY CALCULATION

Vicinity Map

ARCHITECTURAL
SHT T PROJECT DIRECTORY & DATA LEGAL DESCRIPTION, SHEET INDEX, VICINITY
MAP, NOTES & SCOPE OF WORK
A0.01 GENERAL NOTES
A0.02 GENERAL NOTES & ENERGY NOTES

GENERAL NOTES & ENERGY NOTES
CAL GREEN NOTES
CAL GREEN NOTES
ADA DETAILS A0.10 A0.11

Sheet Index:

A0.20 EXISTING SITE PLAN PROPOSED SITE PLAN

PROPOSED SITE PLAN W/ ACCESSIBLE ROUTE TRASH ENCLOSURE FLOOR PLAN & ELEVATIONS PROPOSED FIRST FLOOR & ROOF PLAN A1.03 A1.10 A2.01

A2.02 PROPOSED SECOND & THIRD FLOOR PLAN PROPOSED EAST & WEST BUILDING ELEVATIONS
PROPOSED NORTH & SOUTH BUILDING ELEVATIONS

PRELIMINARY GRADING PLAN PRELIMINARY DRAINAGE PLAN

Project Description

OBSIDIAN PL

DEVELOP A 6 UNIT HAVE A TWO 3-BEDROOMS AND FOUR 1-BEDROOM, GARAGE ON .25 ACRE SITE BY APPLYING THE TOWN DENSITY BONUS PROGRAM.

MAIN ST.

PROJECT

SITE

Legal Description

PARCEL 1 OF PARCEL MAP 36-158 IN THE TOWN OF MAMMOTH LAKES, COUNTY OF MONO, STATE OF CALIFORNIA, AS PER MAP RECORDED IN BOOK 4 PAGE 73 OF PARCEL MAP. IN THE OFFICE OF THE COUNTY RECORDER OF SAID

Project Data

PROJECT ADDRESS: MAMMOTH, CA 93546 033-123-012-000 APN#:

RESIDENTIAL MULTI-FAMILY 1 ZONING TYPE: GENERAL PLAN LAND USE: HIGH DENSITY RESIDENTIAL 1

CONSTRUCTION TYPE:

BUILDING CODE: 2022- CBC, CRC, CMC, CEC, CPC,

10,890 S.F. GROSS (0.25 ACRE) SITE AREA: 9,549 S.F. NET 1) FIRST FLOOR BUILDING: 2,885 S.F.; 30%

2) COVERED PARKING: 885 S.F.; 9% 3) OPENING DRIVEWAY 2.228 S.F.: 23% 4) TRASH ENCLOSURE: 63 S.F.; 1% 5) WALKWAY: LOT COVERAGE I+2+4/9.549= 0.4 (40%)

SNOW STORAGE AREA: 2,295 SF 1,502 SF (OWNER TO PROVIDE PICK-UP COMPAN' 1,502/9,543=0.16 (16%)

LANDSCAPE AREA: 1,022/9,543 S.F.= 0.11 (11%)

SETBACK REQUIREMENTS:

HEIGHT LIMIT:

REQUIRED PROVIDED FRONT YARD SIDE YARD (NORTH) SIDE YARD (SOUTH) 8'-0"(20% REDUCED) 8'-0"(20% REDUCED)

<u>REQUIRED</u> <u>PROVIDED</u> 35'-0" (MAX) ±33'-5"

PER TOWN DENSITY BONUS (WORKFORCE)

2X BASED DENSITY

(PROPOSED 6 UNITS)

PROPOSED BUILDING AREA: FIRST FLOOR: 2,885 S.F. SECOND FLOOR: THIRD FLOOR: 3,129 S.F. 3,152 S.F. 9.166 S.F

OF UNITS PER BASED DENSITY 12 UNITS/ACRES (ALLOW 3 UNITS)

PARKING SPACE REQUIRED: REQUIRED 1/UNIT

1-BEDROOM 4 (4 UNITS) 3-BEDROOM 2/UNIT 4 (2 UNITS) GUEST PARKING 2/4 UNITS 2 (1 REDUCTION PER TOWN DENSITY BONUS) TOTAL 10 SPACES (1 ADA INCL.

REQUIRED PROVIDED EV PARKING

PEGASUS ARCHITECTS

NTS

1717 PIERMONT DRIVE HACIENDA HEIGHTS, CA 91745

TEL: 626.353.3796 E: CHAK@PEGASUSARC.COM

6-UNITS RESIDEN DEVELOPMENT 54 MONO ST., MAMMOTH LAKES, (

RY & DATA DN, SHEET AP, NOTES WORK DESCRIPTION, S, VICINITY MAP, N DIRECTORY ROJECT LEC, INDEX, \ &

Ω SEAL/STAMF

DRAWN BY: TL/ZL SUPERVISED BY: CHECKED BY: PLAN CHECK PERMIT SET __/_/__ RID SET REVISIONS 1 FIRST CUP COMMENTS 02/19/202 SECOND CUP COMMENTS
DESIGN COMMITTEE
COMMENTS 06/12/202

HEET NO

s

н



E

E


Symbols

TYPICAL REFERENCE - DETAIL IDENTIFICATION - SHEET WHERE DETAIL IS DRAWN

SECTION (BUILDING)




 $\overbrace{\stackrel{4}{\text{A3}}}$ SECTION (WALL / DETAIL) ELEVATION

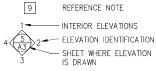







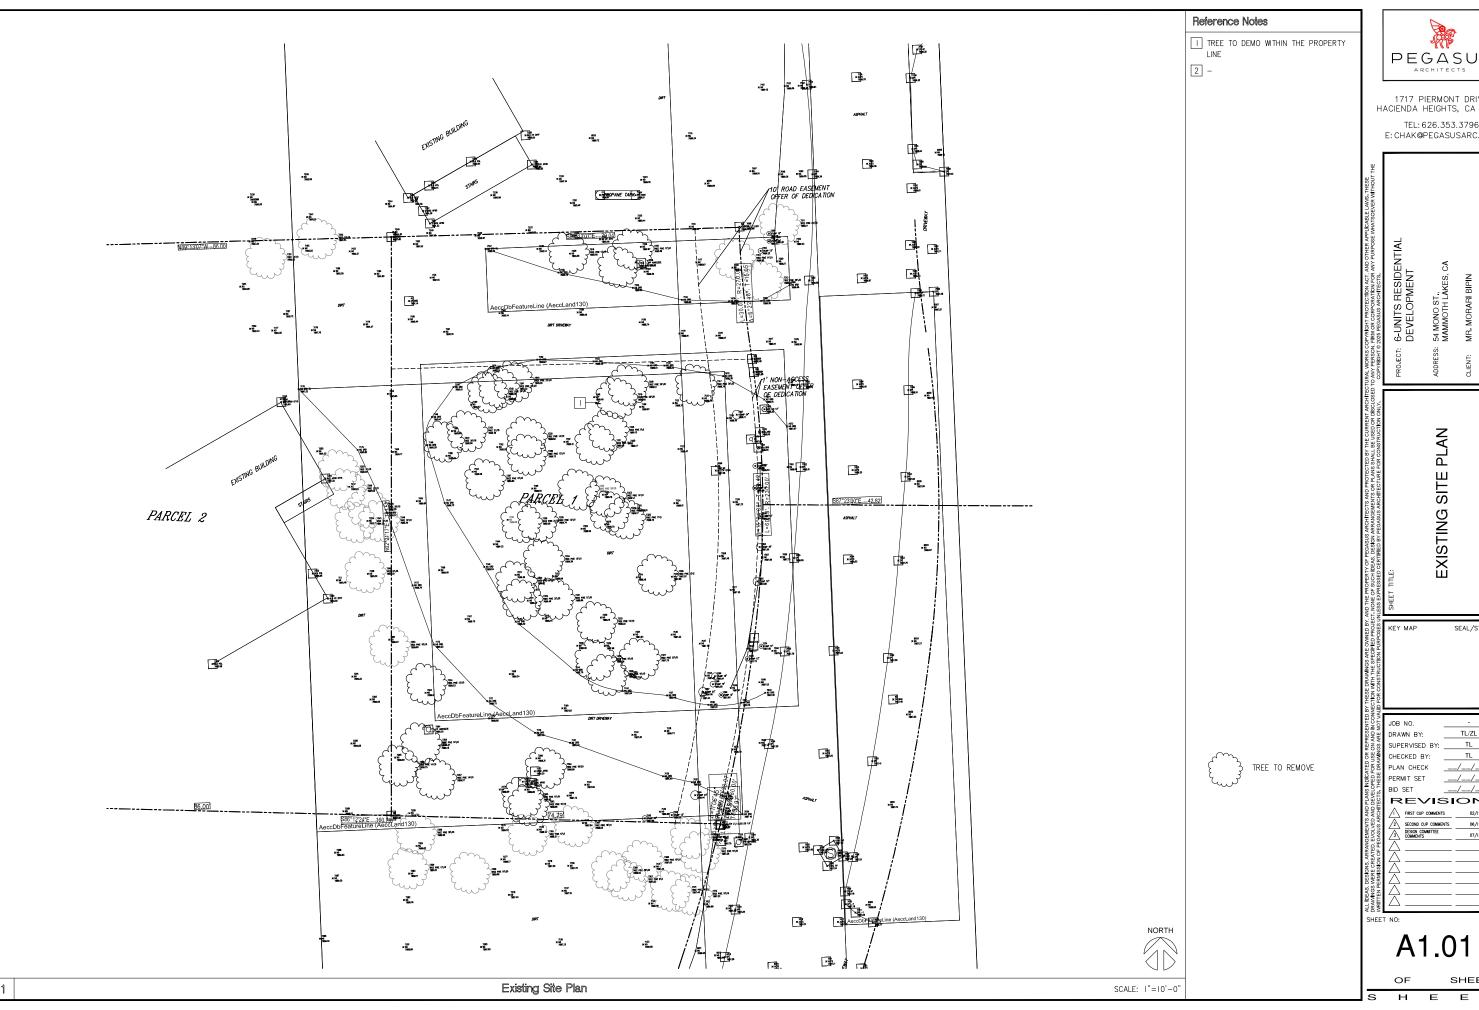

PEGASUS


1717 PIERMONT DRIVE HACIENDA HEIGHTS, CA 91745

TEL: 626.353.3796 E: CHAK@PEGASUSARC.COM

EXISTING SITE PLAN

SUPERVISED BY: ___ REVISIONS FIRST CUP COMMENTS

A1.01

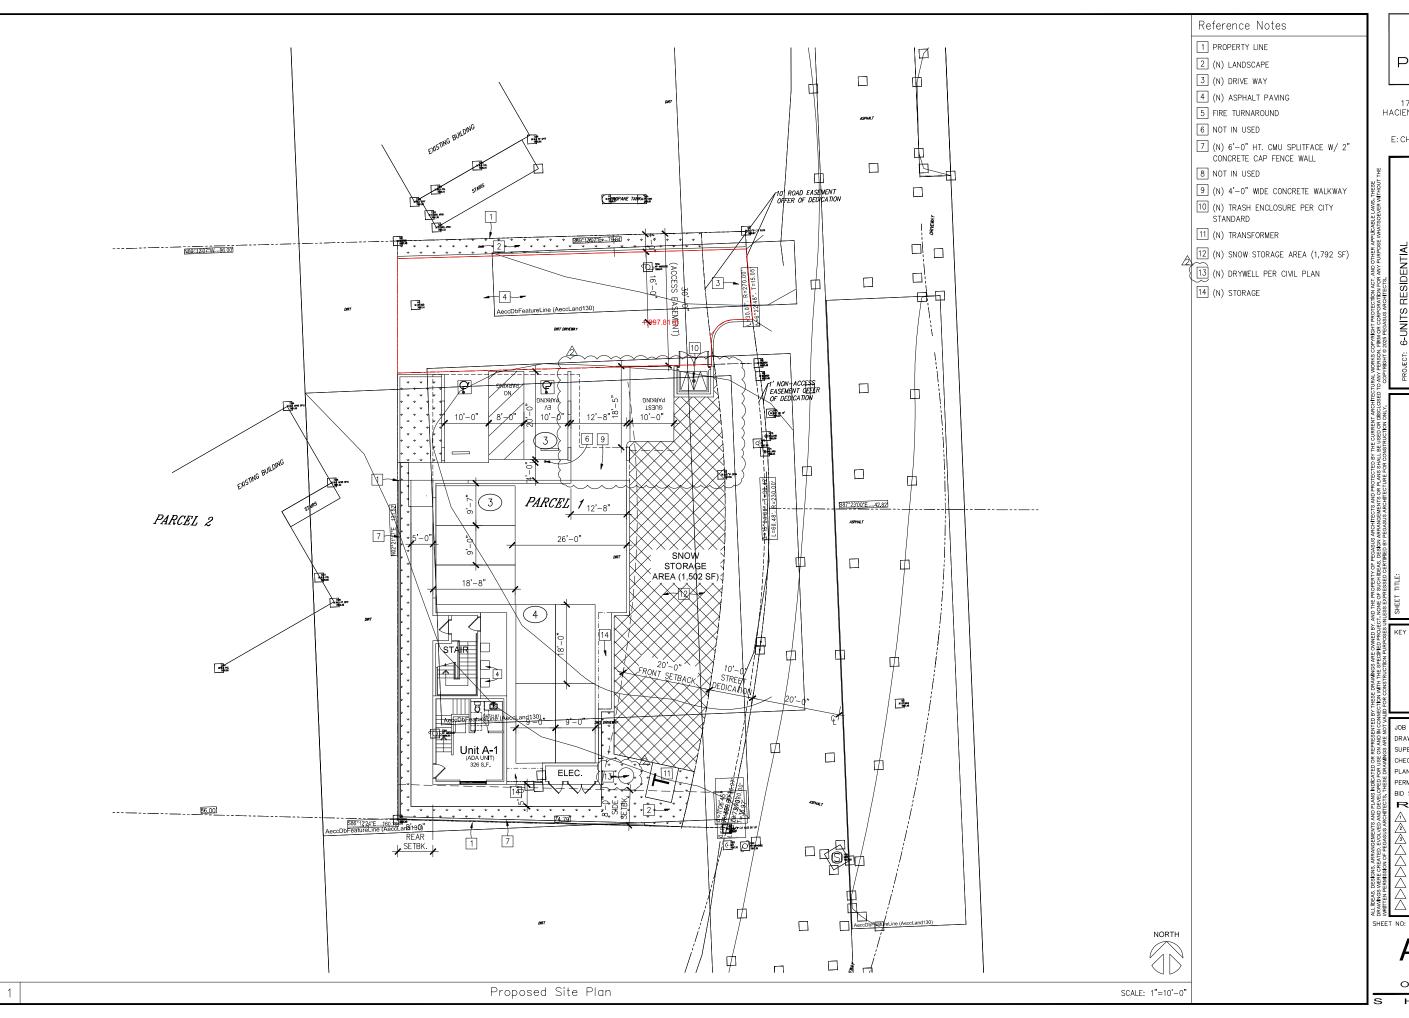



TEL: 626.353.3796 E: CHAK@PEGASUSARC.COM

ORRS COPYRIGHT PROTECTION ACT, AND OTHER APPLICABLE LAWS. THESE PERSON. FIRM OR CORPORATION FOR MAY PURPOSE WHATSOEVER WITHOUT RIGHT & 2025 PEGASUS ARCHITECTS.

JUECT: 6-UNITS RESIDENTIAL
DEVELOPMENT
DEVELOPMENT
MAMMOTH LAKES, CA
MAMMOTH LAKES, CA
MT. MR. MORARI BIPIN

PROPOSED SITE PLAN


KEY MAP SEAL/STAN


JOB NO.


JOB


A1 02

OF SHEETS

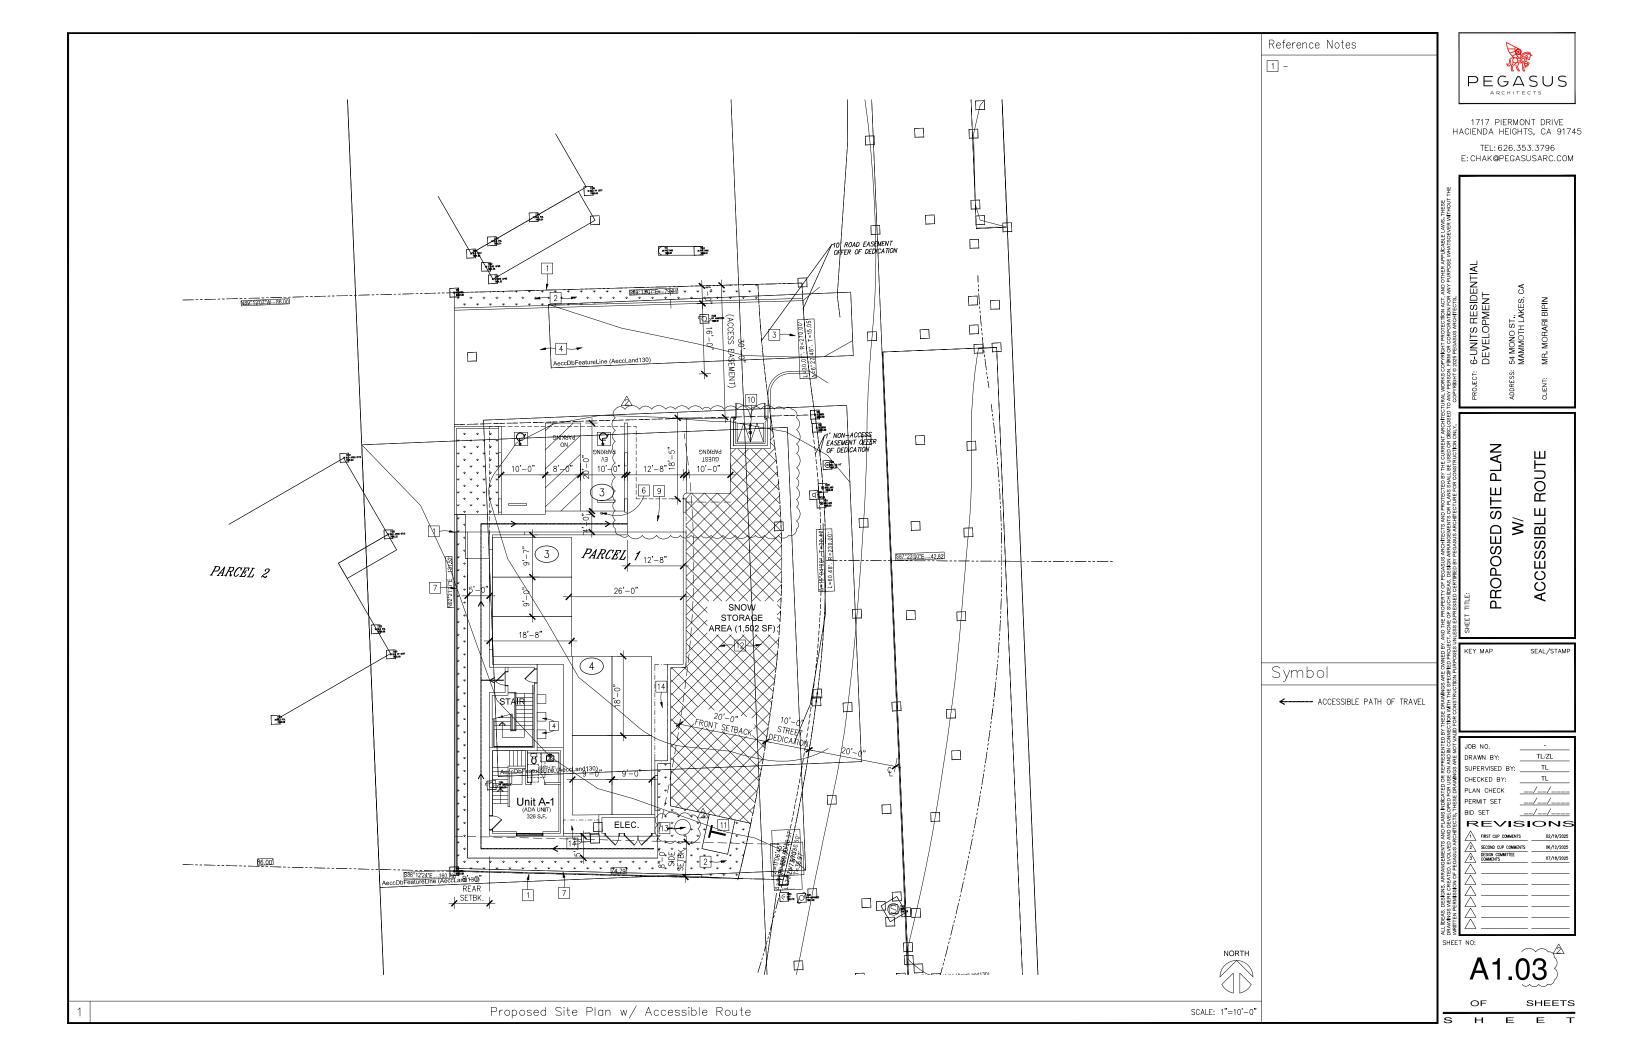

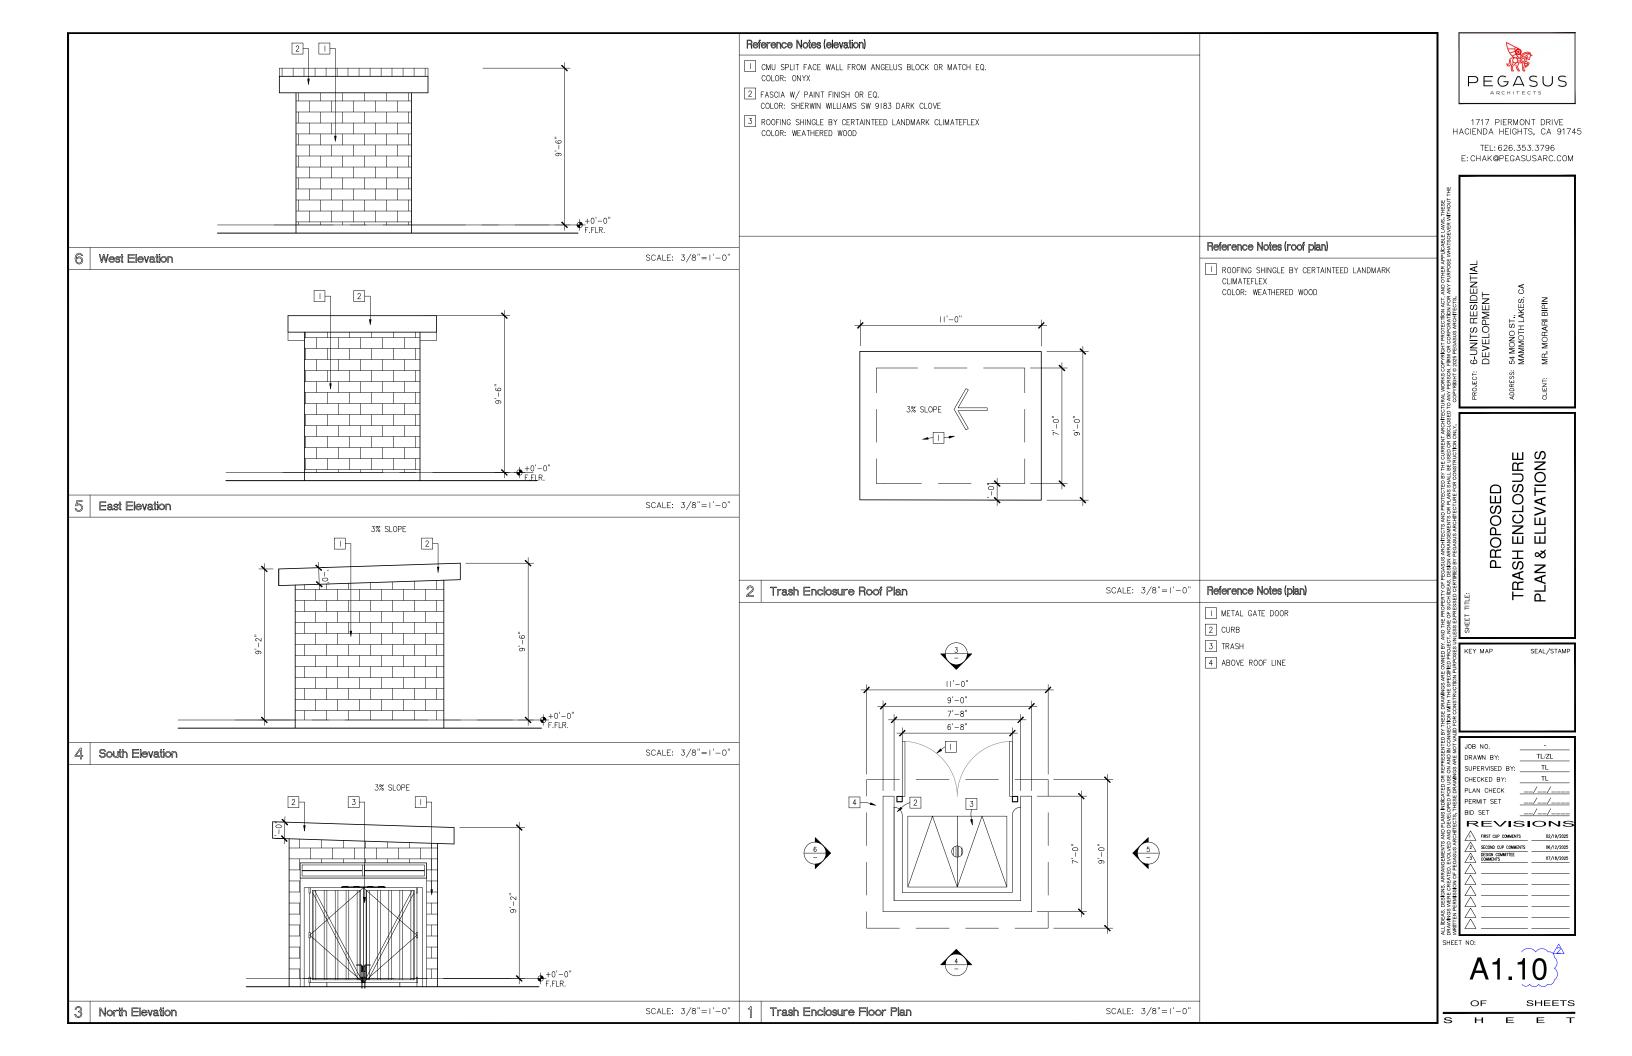

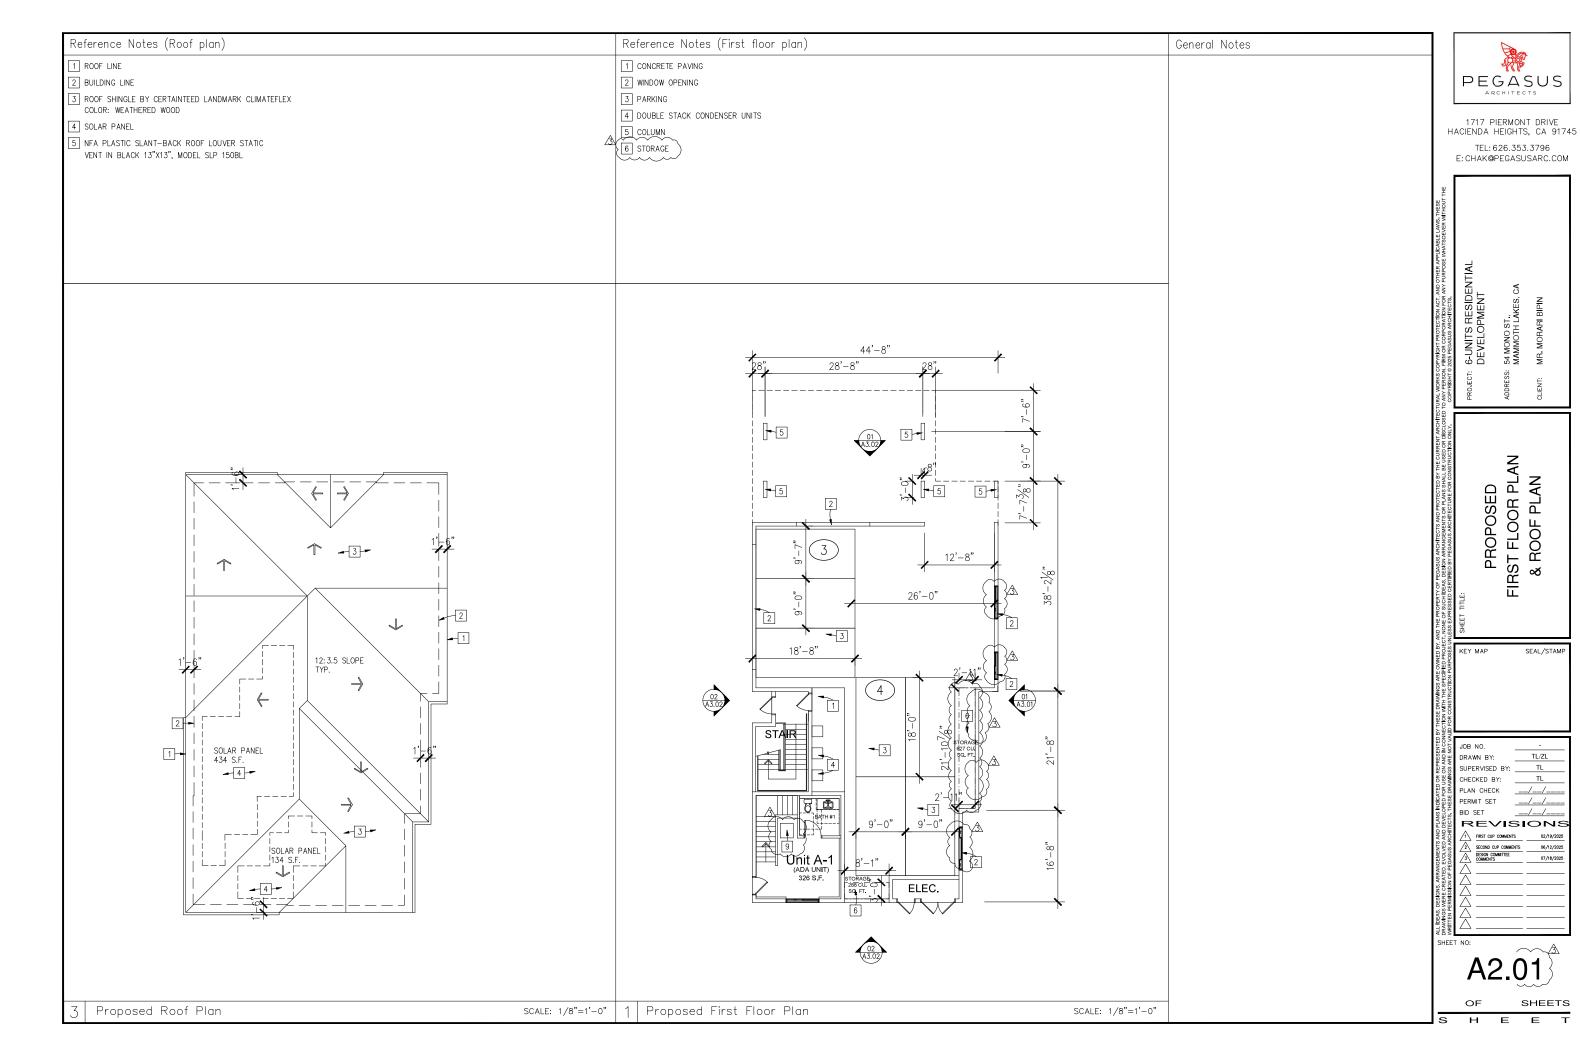

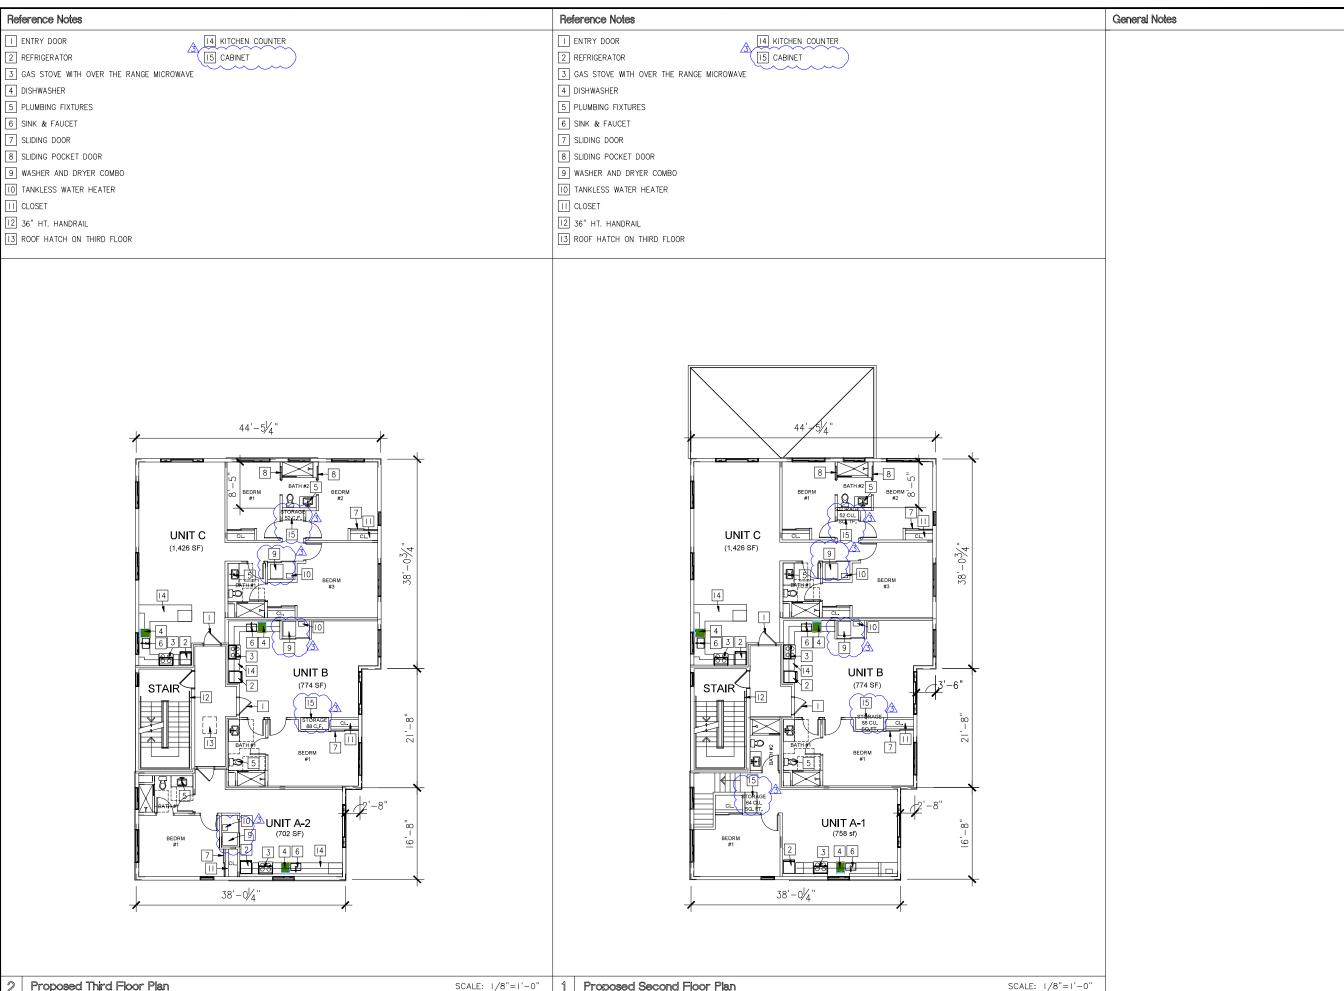



TEL: 626.353.3796 E: CHAK@PEGASUSARC.COM

6-UNITS RESIDENTIA DEVELOPMENT

PROPOSED SECOND & THIRD FLOOR PLAN

DRAWN BY: SUPERVISED BY: CHECKED BY: PLAN CHECK PERMIT SET BID SET REVISIONS FIRST CUP COMMENTS SECOND CUP COMMENTS
DESIGN COMMITTEE
COMMENTS

H E E s






TEL: 626.353.3796 E: CHAK@PEGASUSARC.COM

6-UNITS RESIDEN DEVELOPMENT 54 MONO ST., MAMMOTH LAKES, (

PROPOSED
SINGLE UNIT
ELEVATIONS
(BUILDING "A" & "AR")

DRAWN BY: SUPERVISED BY: CHECKED BY: PLAN CHECK PERMIT SET BID SET REVISIONS 1 FIRST CUP COMMENTS 02/19/202 SECOND CUP COMMENTS
DESIGN COMMITTEE
COMMENTS 06/12/2025

H E

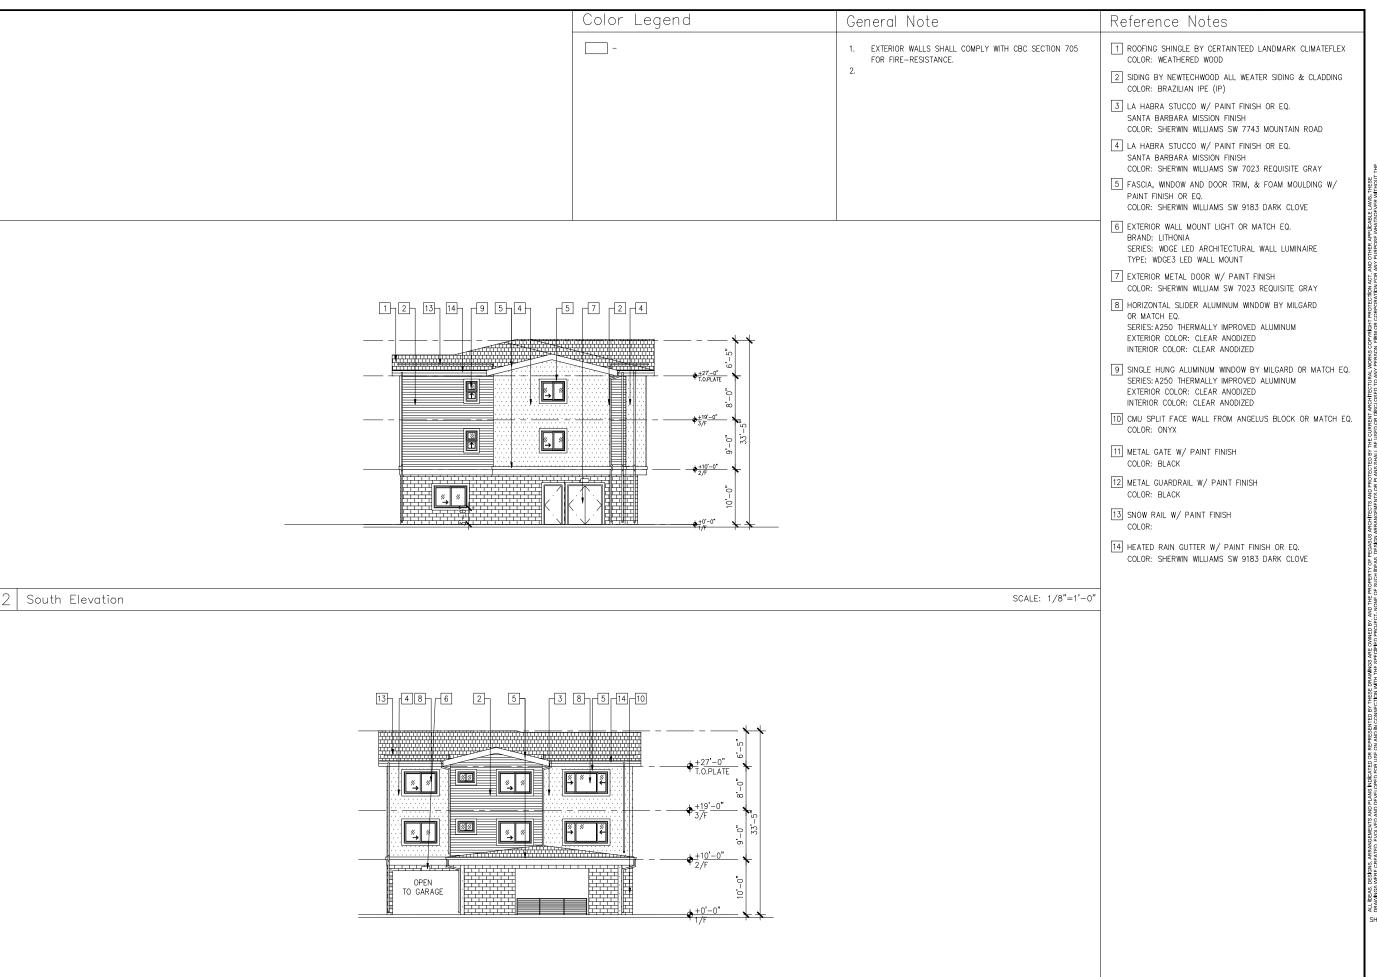

North Elevation



1717 PIERMONT DRIVE HACIENDA HEIGHTS, CA 91745

TEL: 626.353.3796 E: CHAK@PEGASUSARC.COM

AL WORKS COPYRIGHT PROTECTION ACT, AND OTHER APPLICABLE LAWS. THESE
ANY PERSON, FRIM OR CORPORATION FOR ANY PURPOSE WHATSOEVER WITHOUT THE
COPYRIGHT © 2005 PEGASUS ARCHITECTS.
PROJECT: 6-UNITS RESIDENTIAL
DEVELOPMENT
ADDRESS: 54 MONO ST.,
MAMMOTH LAKES, CA
CLENT: MR, MORARI BIPIN

PROPOSED
SINGLE UNIT
ELEVATIONS
(BUILDING "A" & "AR")

KEY MAP SEAL/STAM


SHEET NO:

SCALE: 1/8"=1'-0"

A3.02

H E

OF SHEETS

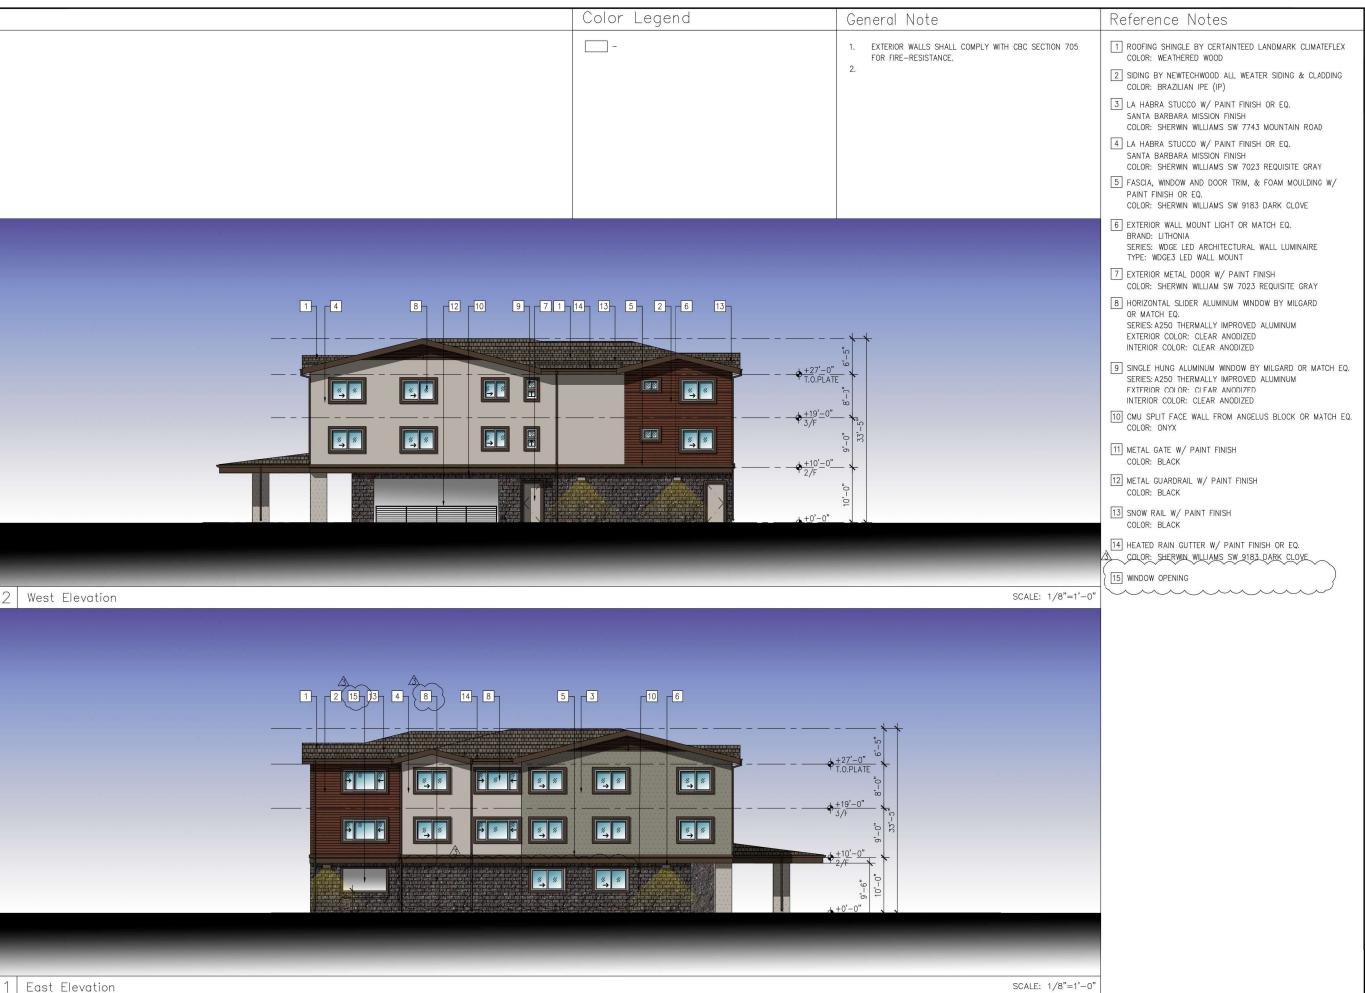



TEL: 626.353.3796 E: CHAK@PEGASUSARC.COM

PERSON FINENT PROTECTION ACT, AND OHER APPLICABLE LAWS THESS PERSON FINENT PROTECTION ACT, AND OHER APPLICABLE LAWS THESS PROMETED TO THE PERSON FINENT PROTECTION ACT AND ACT

PROPOSED SINGLE UNIT ELEVATIONS (BUILDING "A" & "AR")

KEY MAP SEAL/STAMI

DANGE OF THE PROPERTY OF THE P

SHEET NO:

S

A3.01

OF SHEETS

E

H E





TEL: 626.353.3796 E: CHAK@PEGASUSARC.COM

WORKS CEPTRION ACT. AND OTHER ADMISSION STREET PRESENT FROM CORPORATION FOR ANY PURPOSE WANTSOEVER WITHOUT THE STEEDS FEASIES ARCHITECTS.

FOLICT: 6-UNITS RESIDENTIAL

DEVELOPMENT

MAMMOTH LAKES, CA

MAMMOTH LAKES, CA

JENT: MR. MORARI BIPIN

PROPOSED SINGLE UNIT ELEVATIONS (BUILDING "A" & "AR")

KEY MAP SEAL/STAM

JOB NO. - TL/ZL

JOB NO. - TL/ZL

DRAWN BY: TL/ZL

SUPERVISED BY: TL

CHECKED BY: TL

CHECKED

SHEET NO:

A3.02

OF SHEET

H E



6-UNITS RESIDENTIAL DEVELOPMENT 54 MONO ST., MAMMOTH LAKES, CA



SIDING BY NEWTECHWOOD ALL WEATHER SIDING & CLADDING COLOR: BRAZILIAN IPE (IP)



SHERWIN-WILLIAMS, PAINT LA HABRA STUCCO W/ PAINT FINISH OR EQ. SANTA BARBARA MISSION FINISH COLOR: SW 9165 GOSSAMER VEIL



LA HABRA STUCCO W/ PAINT FINISH OR EQ. SANTA BARBARA MISSION FINISH SHERWIN-WILLIAMS, PAINT COLOR: SW 9183 DARK CLOVE



ROOFING SHINGLE BY CERTAINTEED LANDMARK CLIMATEFLEX COLOR: WEATHERED WOOD



FASCIA, WINDOW AND DOOR TRIM & FOAM MOULDING

W/ PAINT FINISH OR EQ. SHERWIN-WILLIAMS, PAINT COLOR: SW 9183 DARK CLOVE



EXTERIOR WALL MOUNT LIGHT OR MATCH EQ.


BRAND: LITHONIA
SERIES: WDGE LED ARCHITECTURAL WALL LUMINAIRE
TYPE: WDGE3 LED WALL MOUNT




CMU SPLIT FACE WALL FROM ANGELUS BLOCK OR MATCH EQ.

COLOR: MOSS



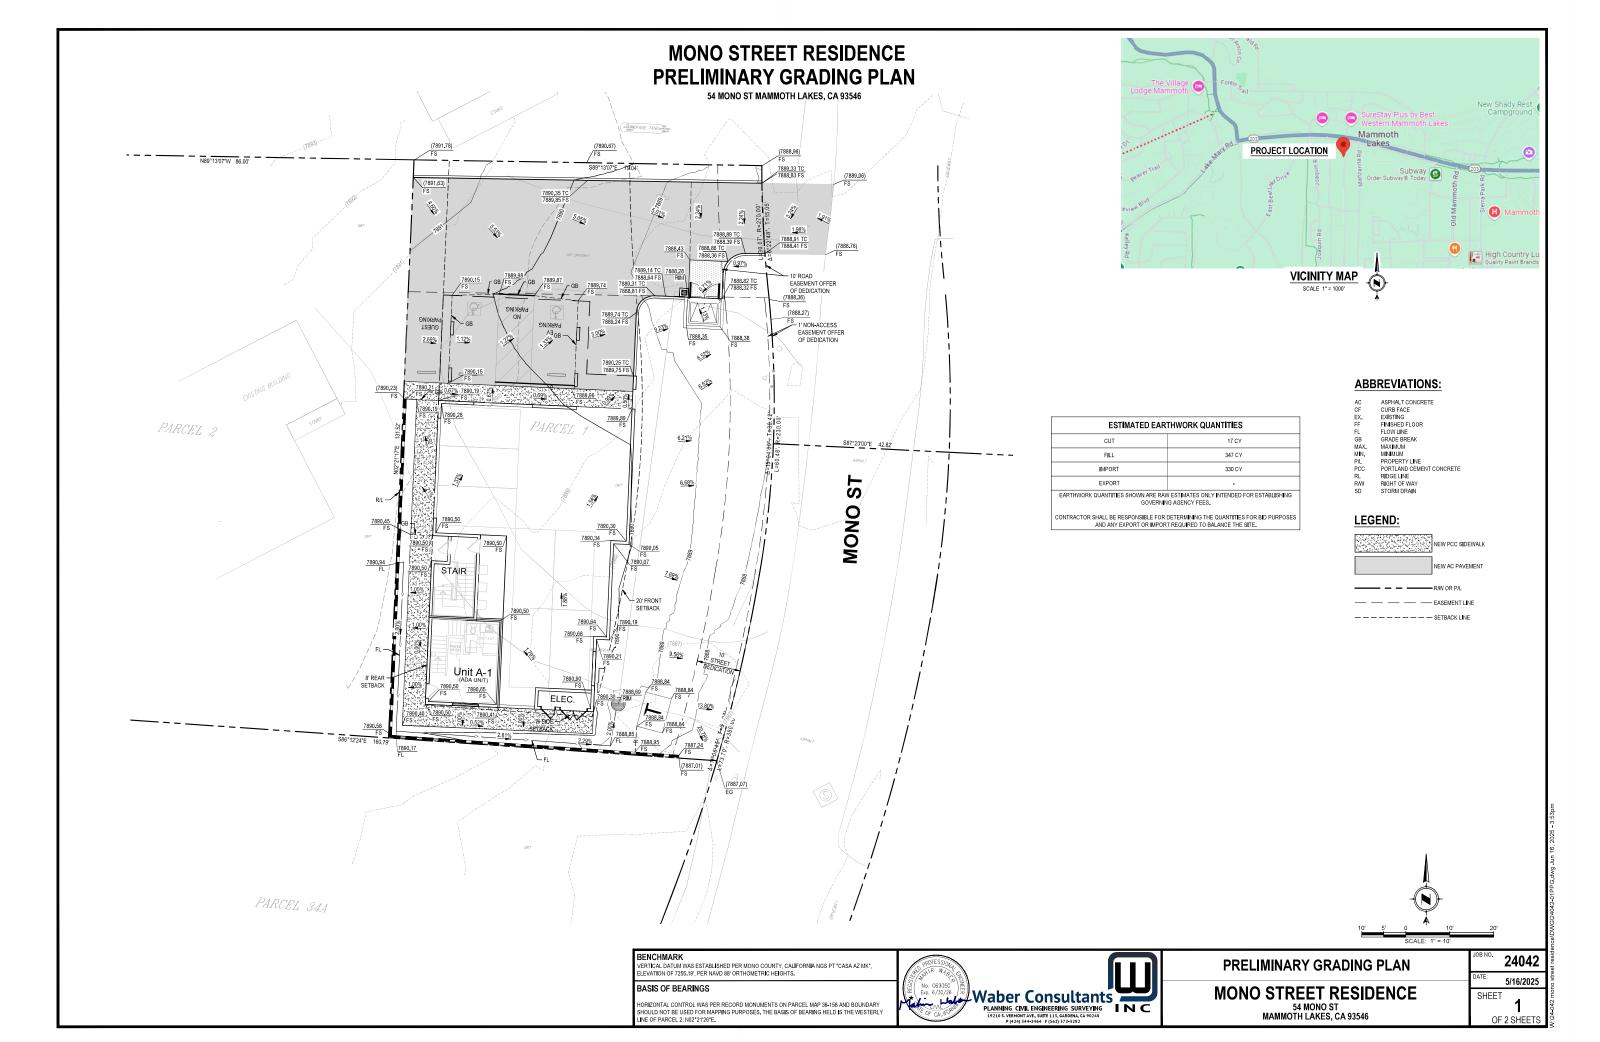


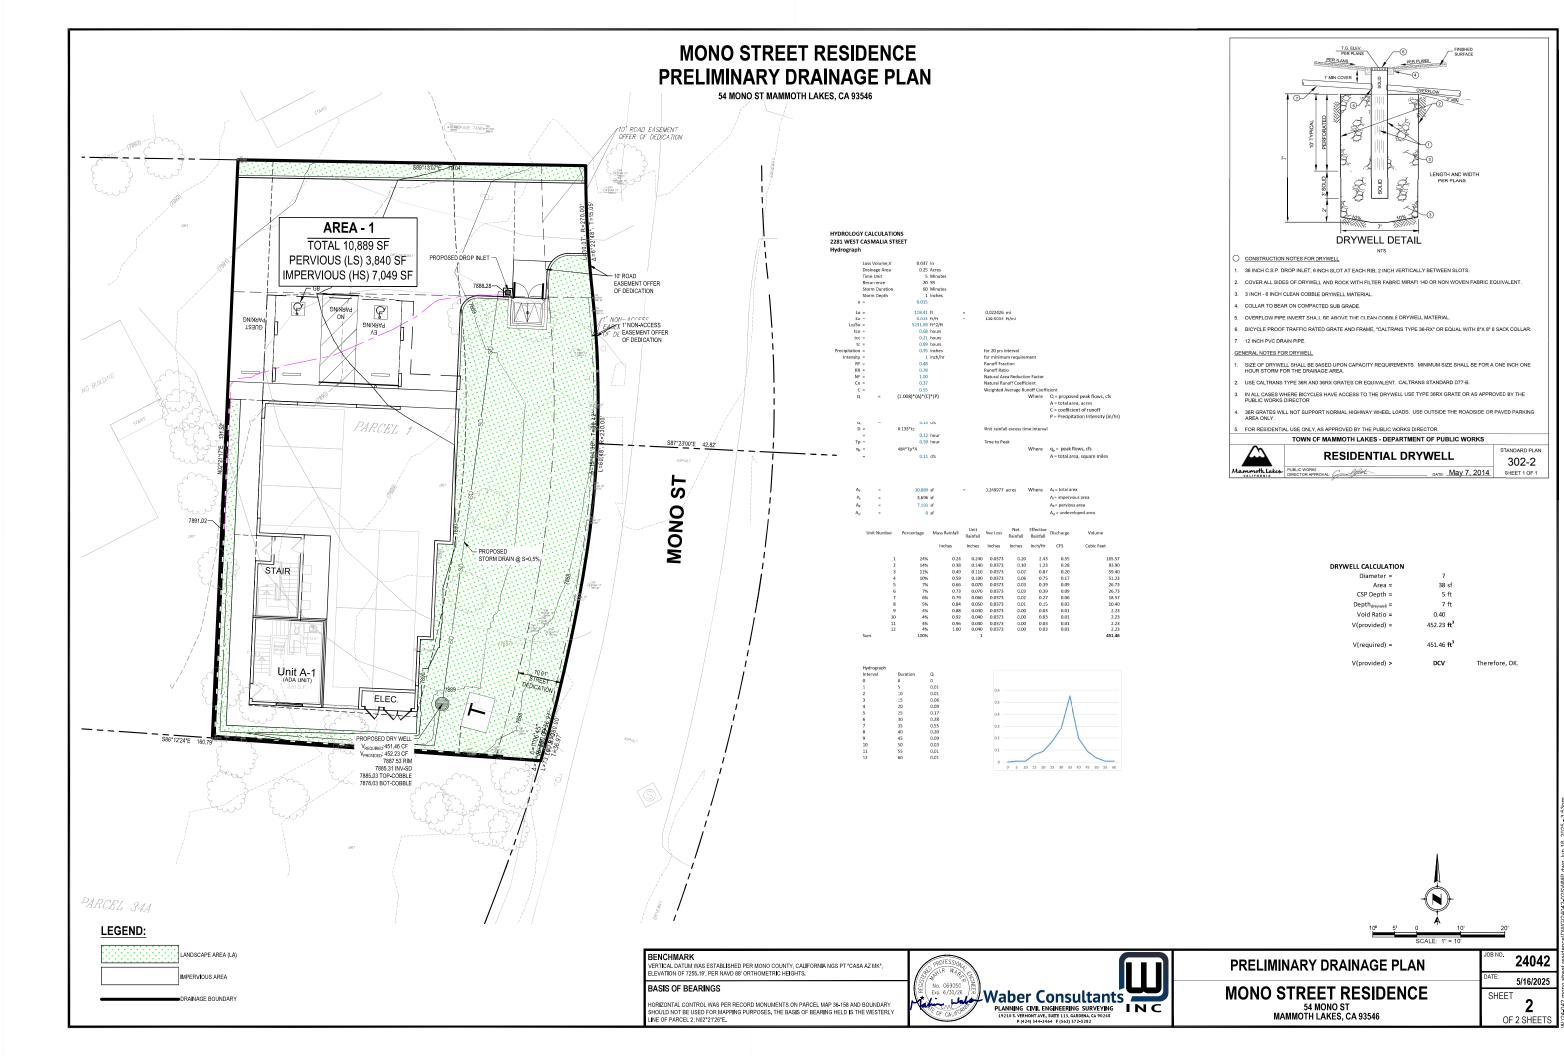

ARCHITECTURAL LANDSCAPE PLANS

6-UNITS RESIDENTIAL DEVELOPMENT 54 MONO ST.,

MAMMOTH LAKES, CA 93546

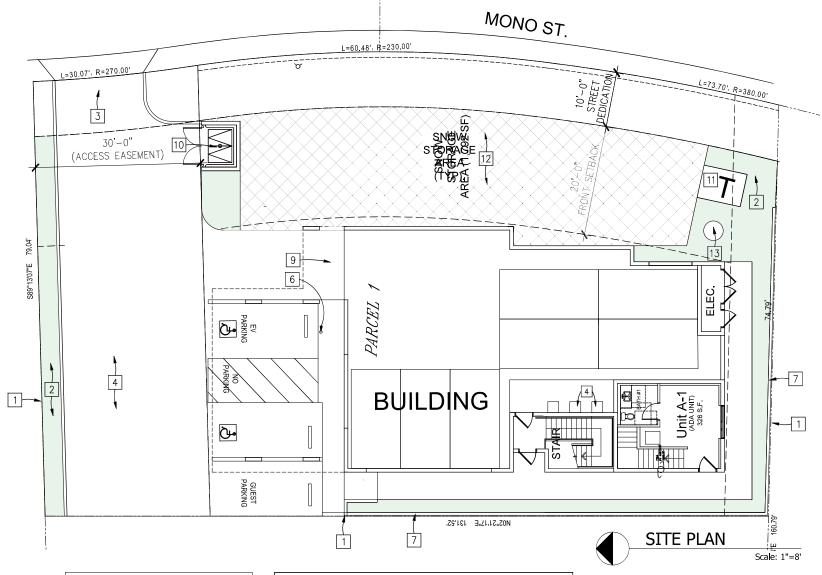

MAINTENANCE RESPONSIBILITY All improvements to be maintained by developer/property owner.

RECOMMENDED MINIMUM LANDSCAPE MAINTENANCE SCHEDULE

to Agronomical Soil's report on these plans

- Check all irrigation equipment and adjust/ align as required.
- Record all inglation equipment with originally specified materials as needed.
 Inspect all landscape areas for pests/ pathogens.
 Weed all shrub/ groundcover areas as needed.
- Remove landscape debris.
- Aerating and dethatching turf areas.

 Repair planting well and/ or grade around plants to eliminate runoff.


 Perform corrective pruning to eliminate hazards and damage to plant after
- 2nd Year of Growth.

MINIMUM RECOMMENDED YEARLY MAINTENANCE SCHEDULE

Month	Jan	Feb	Mar	Apr	May	Jun	Jul	Aug	Sep	Oct	Nov	Dec
Adjust Irrigation Schedule	V	1	1	V	V	V	V	V	1	1	1	V
Inspect Tree Staking	٧	٧	٧	٧	٧	V	٧	V	V	1	V	٧
Flush Drip Valves			1			V			V			٧
Add Mu l ch (Maintain 3" Layer)			٧			√			V			1
Eartifization: Deference												

Reference Notes

- 1 PROPERTY LINE
- 2 (N) LANDSCAPE
- 3 (N) DRIVE WAY
- 4 (N) ASPHALT PAVING
- 5 FIRE TURNAROUND
- 6 NOT IN USED
- 7 (N) 6'-0" HT. CMU SPLITFACE W/ 2" CONCRETE CAP FENCE WALL
- 9 (N) 4'-0" WIDE CONCRETE WALKWAY
- 10 (N) TRASH ENCLOSURE PER CITY
- 11 (N) TRANSFORMER
- 12 (N) SNOW STORAGE AREA (1,792 SF)
- 13 (N) DRYWELL PER CIVIL PLAN

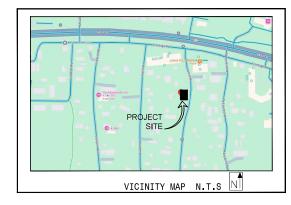

TOTAL LANDSCAPE AREA = 869 s.f.

SHEET INDEX						
L-1	TITLE SHEET					
L-2	PLANTING PLAN					
L-3	IRRIGATION PLAN					
L-4	IRRIGATION DETAILS					

Project Directory

OWNER: MR.MORARI BIPIN 54 MONO ST., MAMMOTH LAKES, CA

ARCHITECT: C.F. LAU, A.I.A. PEGASUS ARCHITECTS 4300 EDISON AVE.. TEL: (909) 465.4101

CIML: BLUE ENGINEERING & CONSULTANTS MARTIN GONZALEZ 9320 BASELINE RD., SUITE D RANCHO CUCAMONGA, CA 91710 TEL: (909) 970-5654

LANDSCAPE ARCHITECT: PHILMAY LANDSCAPE ARCHITECT ROSALIO SERNA 2532 WALLACE AVENUE FULLERTON, CA 92831

Scope Of Work

NEW CONSTRUCTION OF A 6-UNITS RESIDENTIAL APARTMENTS

CERTIFICATION OF LANDSCAPE DESIGN

I hereby certify that:

- sional landscape design services. The landscape design and water use calculations for the property located at
- supervision.
 (4) The landscape design and water use calculations for the identified property
- (4) The landscape design and water use acticulations for the identified properly comply with the requirements of the City of Mammoth Water Efficient Landscape Ordinance (Municipal Code Chapter 13.18) and the City of Mammoth Water Efficient Landscape Guidelines.

 (5) The information I have provided in this Certificate of Landscape Design is true and correct and is hereby submitted in compliance with the City of Mammoth Water Efficient

PHIL MAY	
Print Name	
Pul N	lay
Signature	- /

1937 W/ 9 TH. STREET UPLAND, CA 91786 Address

(909) 373-1959 Telephone Landscape Design Professional's Stamp





LANDSCAPE ARCHITECTURE

2532 Wallace Ave

Phone:909 373 1959



COVER SHEET

6-UNITS RESIDENTIAL DEVELOPMENT 54 MONO ST., MAMMOTH LAKES, C.

DRAWN R.S. CHECKED

JOB NO. 24089



PLANTING NOTES

- Contractor is to review plans, verify site conditions and plant quantities prior to installation. Contractor shall take sole responsibility for any cost incurred due to damage of existing utilities. Plant material quantities are listed for the convenience of the Contractor. Actual number of symbols shall have priority over quantity designated. Conflicts between the Owner and these plans or within these plans shall be brought to the attention of the Landscape Architect prior to landscape installation. Any deviation(s) from the plans or specifications will require written approval from the Owner and/or Landscape Architect. The Contractor shall assume full responsibility for all necessary revisions due to failure to give such notification.
- The Contractor shall maintain a qualified supervisor on the site at all times during construction through completion pick—up work.
- The Contractor shall receive site graded within 0.10 foot of finish grade. Commencement of work indicates Contractor's acceptance of existing grades and conditions. Final grades shall be adjusted by Contractor as directed by Owner's representative. All grading shall be completed prior to commencement of planting operation.
- The Contractor shall furnish and pay for all container grown trees, shrubs, vines, seeded/sodded turf, hydromulches, and flatted groundcovers. The Contractor shall also be responsible for and pay for planting, staking, and guarantee of all plant materials. See planting details for planting and staking/guying requirements.
- The Landscape Architect and/or Owner shall approve plant material placement by Contractor prior to installation.
- Contractor shall follow the soil's report recommendations, and shall uniformly broadcast amendments over planting areas only. Landscape contractor to attain Agronomical Soils report after all major grading has been completed.
- The planting pits for trees shall be dug twice the diameter of the root ball and two inches shallower than the rootball. Planting pits for shrubs and perennials shall be dug twice the original root ball width, and one—and—a-half times as deep as the rootball. Planting pits for groundcovers shall be dug one—and—a-half times the original root ball size in all directions.
- Provide root barriers to all new trees planted within five(5) feet of paved areas. The root barrier shall be installed per manufacture specifications. For trees planted in square or circular tree wells; the root barrier shall be install around entire perimeter edge of the well planter.
- Provide jute netting on all slopes 4:1 or greater.
- 10. The Landscape Contractor shall maintain all planted areas shown on the plans, including (but not limited to) watering, pruning, edging, and mowing, for a period of thirty (30) days after completion of project and acceptance by Owner.
- The Landscape Contractor shall warranty and replace any plant material that shows signs of lack of vigor or other unhealthful appearance within ninety (90) days of completion of contract. Trees that have been tapped or otherwise improperly pruned by the Contractor shall be removed and replaced by the Contractor at no cost to the Owner.

E. If the tree(s) will be subject to maintenance work such as lawn mowing or weed trimming we strongly recommend the installation of ArborGard+ Tree Trunk Protectors which is


PLANT LEGEND

A minimum 3-inch layer of mulch shall be applied on all exposed soil surfaces of planting areas except turf areas, creeping or rooting ground covers, or direct seeding applications where mulch is contraindicated."

NOTES

- 2. A Certificate of Completion shall be filled out and certified by either the designer of the landscape plans, irrigation plans, or the licensed landscape contractor for the project".
- 3. For soil amendments see 'Planting Notes', #7.

SYMBOL	BOTANICAL NAME	COMMON NAME	SIZE	QTY.	WUCOLS
\wedge	TREES				
$\langle \langle \langle \rangle \rangle$	Ginkgo Biloba 'Fastigiata'	Maidenhair Tree	24" box	4	L
	Betula pendula	White Birch	24" box	1	L
	SHRUBS		24" box		
	Berberis thunbergii	Japanese Barberry	5 gal	2	L
	Photinia Fraseri	Red Tip Photinia	5 gal	38	М
-	PERENNIALS				

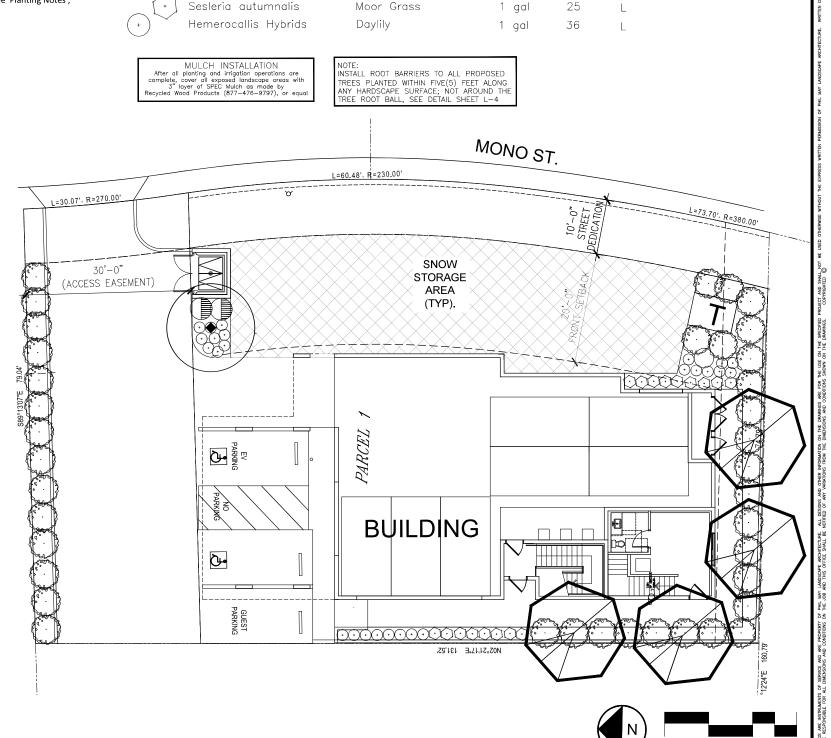

Linear Style Planting with DeepRoot Barriers

A. Dig the trench to the depth based upon the particular


B. Install the barrier. When using DeepRoot Linear Barriers simply pull the appropriate number of panels out of the box (they come preasembles) and separate the pioner at the correct length. When installing DeepRoot Universal Barriers in a linear fashion you will need to join the appropriate number of panels together.


C. Next place the barrier in the trench with the vertical ribs facing toward the tree and align in a straight fashion. It is helpful to place the barrier against the hardscape. Use the hardscape as a guide and backfill against the barriers to premate a clean smooth fit to the hardscape as selected to be supported to the premate hardscape to the surface of the hardscape. Be sure to keep the barrier's double top edge at least 1/2" (15mm) belove grade to ensure roots do not grow over the top.


or a simple formula to determine the quantity of panels required for a Linear application use

As little as one side of the tree may need borrier for root direction as there may be no hardscape else—where requiring protection.

LB 12-2 80' (24 m) per Carton LB 18-2 52' (16 m) per Carton

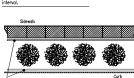

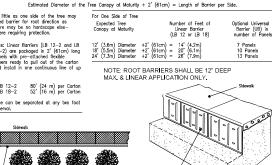

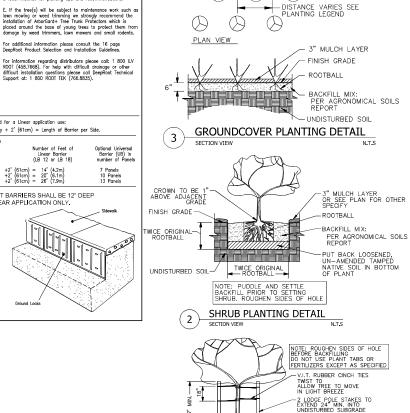

CROWN TO BE 2" ABOVE ADJACENT GRADE


PROVIDE ROOTBARRIER 10' LINEAR FEET MIN. BY 12" DEEP FOR TREES PLANTED WITHIN 5' OF PAVED AREA

- PLANT GROUNDCOVER TRIANGULAR SPACING SEE LEGEND FOR DISTANCE

 \bigcirc

 \bigcirc



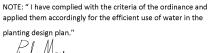

Trul May 06-18-2025 Phil May, Landscape Architect

3" MULCH LAYER-

UNDISTURBED SOIL-

TREE PLANTING DETAIL

SECTION VIEW

ЈОВ NO. 24089

REVISIONS

PHIL MAY

LANDSCAPE

ARCHITECTURE

2532 Wallace Ave. Fullerton, CA 92831

Phone:909 373 1959 may@philmaydesign.com

ww.philmavdesign.com

PLAN

PLANTING

Ö

6-UNITS RESIDENTIAL DEVELOPMENT 54 MONO ST., MAMMOTH LAKES, C

RS

DATE 06-18-2025

REMARKS

Standard trunk

Standard trunk

IRRIGATION NOTES

- 1. It is the responsibility of the irrigation Contractor to familiarize himself with all grade differences, location of wall, retaining walls, structures and utilities. The Contractor shall repair or replace, at no additional cost to the owner, all items damaged by his work. The Contractor shall coordinate his work with other contractors for the location and installation of pipe sleeves and laterals through walls, under roadways and paving, etc.
- 2. The Contractor shall not willfully install the irrigation system as shown on the drawings when it is obvious in the field that unknown obstructions, grade differences, or differences in the area dimension exist that might not have been addressed in the design of the irrigation system. Such obstructions or differences shall be brought to the attention of the Owner's authorized representative. In the event this notification is not performed, the Contractor shall assume full responsibility for any necessary alterations to the work.
- 3. The Contractor shall obtain, coordinate, and pay for any and all inspections as required.
- The Contractor shall be responsible and liable for any encroachment into adjacent property, R.O.W.'s easements setbacks or any other legal property restrictions either marked or unmarked.
- 5. The irrigation system design is based on a minimum operation pressure of 40 PSI and a maximum flow demand of 15.0 GPM. The Contractor shall verify water pressure prior to construction. Report any difference between the water pressure indicated on the drawings and the actual pressure reading at the irrigation point of connection to the Landscape Architect.
- 7. Trenching within the dripline of large existing trees shall be performed by hand, and with extreme care not to sever roots $1-1/2^2$ in diameter and larger. Where roots $1-1/2^2$ in diameter and larger are encountered, the Contractor shall tunnel under said roots. Exposed roots that have been tunneled under shall be wrapped in wet having and kept moist while
- 8. All purple Main line piping, lateral line piping, and control wires under paving shall be installed in Purple Schedule 40 PVC sleeves at a minimum depth of 18". Sleeves shall be installed before paving is in place. All sleeve sized shall be a minimum of twice the diameter of the pipe to be sleeved. Control wire sleeves shall be of sufficient size for the required number of wires under paving.
- Pipe sizes shall conform to those shown on the drawings. No substitutions of smaller pipe sizes shall be permitted, but substitutions of larger sizes may be approved. All damaged and rejected pipe shall be removed from the site at the time of said rejection.
- 10. The Contractor shall flush and adjust all sprinkler heads, drip tubing, and valves for optimum coverage with minimal misting and/or over spray onto walks, streets, walls, etc. Substitution of nozzle pattern or radius as required to ach optimum coverage is responsibility of contractor.
- 11. All irrigation equipment not otherwise detailed or specified shall be installed as per manufacturer's recommendations
- 12. Drip tubing shall be installed in parallel rows (wherever possible) 18" apart on top the finish grade (unless stated otherwise on plan OR irrigation legend) and covered with 3" of specify groundcover material—see planting plan. Emitter spacing of adjacent rows staggered. Tubing shall be firmly staked in place with U—staples at 5' on center (24" on center around tight curves). In steeply sloped areas, install tubing rows perpendicular to the direction of the slope, install flush valves at the circuit's major low points (verify in field). Install flush valves in 6" valve boxes. Drip irrigation tubing shall be connected to Schedule 40 PVC supply line and exhaust manifolds where indicated on the plans.
- 1.3. All remote control valves, gate valves, flush valves, and pressure relief valves shall be installed in suitable valve boxes as shown in details, complete with locking covers. All shall be Carson, Amtec, or approved equal, and shall be marked "G.V." for gate valves, "R.C.V." for remote control valves, etc. Provide expansion coils at each wire connection in valve box as per details.
- 14. Install all backflow prevention devices and all piping between the point of connection and the backflow preventer as per local codes. Final location of the backflow preventer and automatic controller shall be approved by the Owner.

Water Efficient Landscape Workshee

- 15. 120 VAC electrical power source at controller location shall be provided by Electrician or General Contractor. The Contractor shall make the final connection from the electrical source to the controller.
- 16. Pressure test Mainline at 150 PSI per three(3) hours constant.
- 17. ALL IMPROVEMENTS SHALL COMPLY WITH THE STANDARD UNIFORM BUILDING CODE.

1. Check valves or anti-drain valves are required on all sprinkler heads where low point drainage could occur.

KEY NOTES

NOTE:

2. A diagram of the irrigation plan showing hydrozones shall be kept with the irrigation controller for subsequent management purposes.

3. An irrigation audit report shall be completed at the time of final inspection.

- 4. At the time of final inspection, the permit applicant must provide the owner property with a certificate of completion of installation, irrigation schedule of landscape and irrigation maintenance."
- 5. "Unless contradicted by a soils test, compost at a rate of a minimum of four cubic yards per 1,000 square feet or permeable area shall be incorporated to a depth of six inches into the

THIS DESIGN IS DIAGRAMMATIC FOR CLARIFICATION. THE LOCATION

OF MAINLINES, LATERALS, VALVES,

AREAS AS MUCH AS POSSIBLE. VERIFY WITH GENERAL CONTRACTOR.

AND OTHER IRRIGATION COMPONENTS

SHALL BE LOCATED INSIDE PLANTER

GENERAL SLEEVING NOTE

GENERAL PIPE LOCATION NOTE

MAININE AND LATERAL LINES ARE SHOWN
DAGRAMMATICALLY ON PLANTER WITH THE MINIMUM
QUANTITY OF FITTINGS AND CHANGE OF INCECTION,
COORDINATE WITH THE MINIMUM
COORDINATE WITH THE MINIMUM
COORDINATE WITH THE TRADES TO AVOID CONFLICTS
WITH UTILITIES AND PANIME.

Water Pressure at meter or at pressure reducer_____80 PSI HUNTER Irrigation Controller Brand Valve type- Irrigation type (drip, low flow, etc.) Mfr rated flow fime period (minutes/day) 30 0.25 7 4 DRIP 0.5 LOW 15 22.5 7 2 MEDIUM BUBBLER 90

Irrigation Schedule (Established - Mature Planting)


80 PSI Water Pressure at meter or at pressure reducer__

Irrigation Schedule (Establishment Period)

rrigatior	n Controller Brand,		TIONT	LIX			
Valve No.	Hydrozone type- high, med., low	Irrigation type (drip, low flow, etc.)	Mfr rated flow GPH	Application time period (minutes/day)	Total gallons =(GPH) x (1hr/60min) x (#minutes)	Days per week Summer	Days per week Winter
1	LOW	DRIP	0.5	30	0.25	4	2
2	MEDIUM	BUBBLER	90	15	22.5	4	2

LOCATE BACKFLOW

DEVICE IN PLANTING

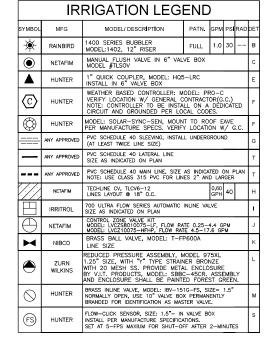

VALVE NUMBER GPM


HYDROZONE WATER USAGE

SYMBOL LEGEND

I – LOW WATER

M - MEDIUM WATER VALVE SIZE - HIGH WATER VERIFY P.O.C. MONO ST. IN FIELD L=60.48', R=230.00' L=30.07', R=270.00' SNOW M STORAGE AREA (TYP). ´1 | 8 DRIP-TYP. 3/4 IDENTIFY THE LOWEST FLEVATION POINT FOR EACH SYSTEM AND INSTALL WEATHER STATION -A FLUSH VALVE PER DETAIL. TREE BUBBLER INSTALL PER MANUF. PARCEL (TYPICAL) SPECS. AR E IRRIGATION CONTROLLER -MOUNT TO WALL FACE VERIFY LOCATION W/ GENERAL CONTRACTOR BUILDING

> 131.52" 131.52" NO2"21" 131.52"

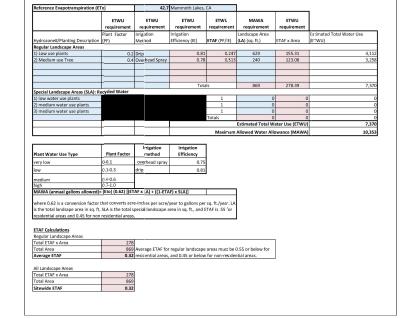




NOTE: "I have complied with the criteria of the ordinance and applied them accordingly for the efficient use of water in the rrigation design plan."

This May 06-18-2025 Phil May, Landscape Architect

All improvements are to be maintained by the property owner. NOTE: SEE SHEET L-4 FOR IRRIGATION DETAILS

Şu

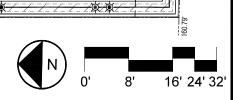

REVISIONS



ARCHITECTURE 2532 Wallace Ave

Phone:909 373 1959

nay@philmaydesign.com




PLAN RIGATION

Ö 6-UNITS RESIDENTIAL DEVELOPMENT 54 MONO ST., MAMMOTH LAKES, C

RS 06-18-2025

JOB NO. 24089

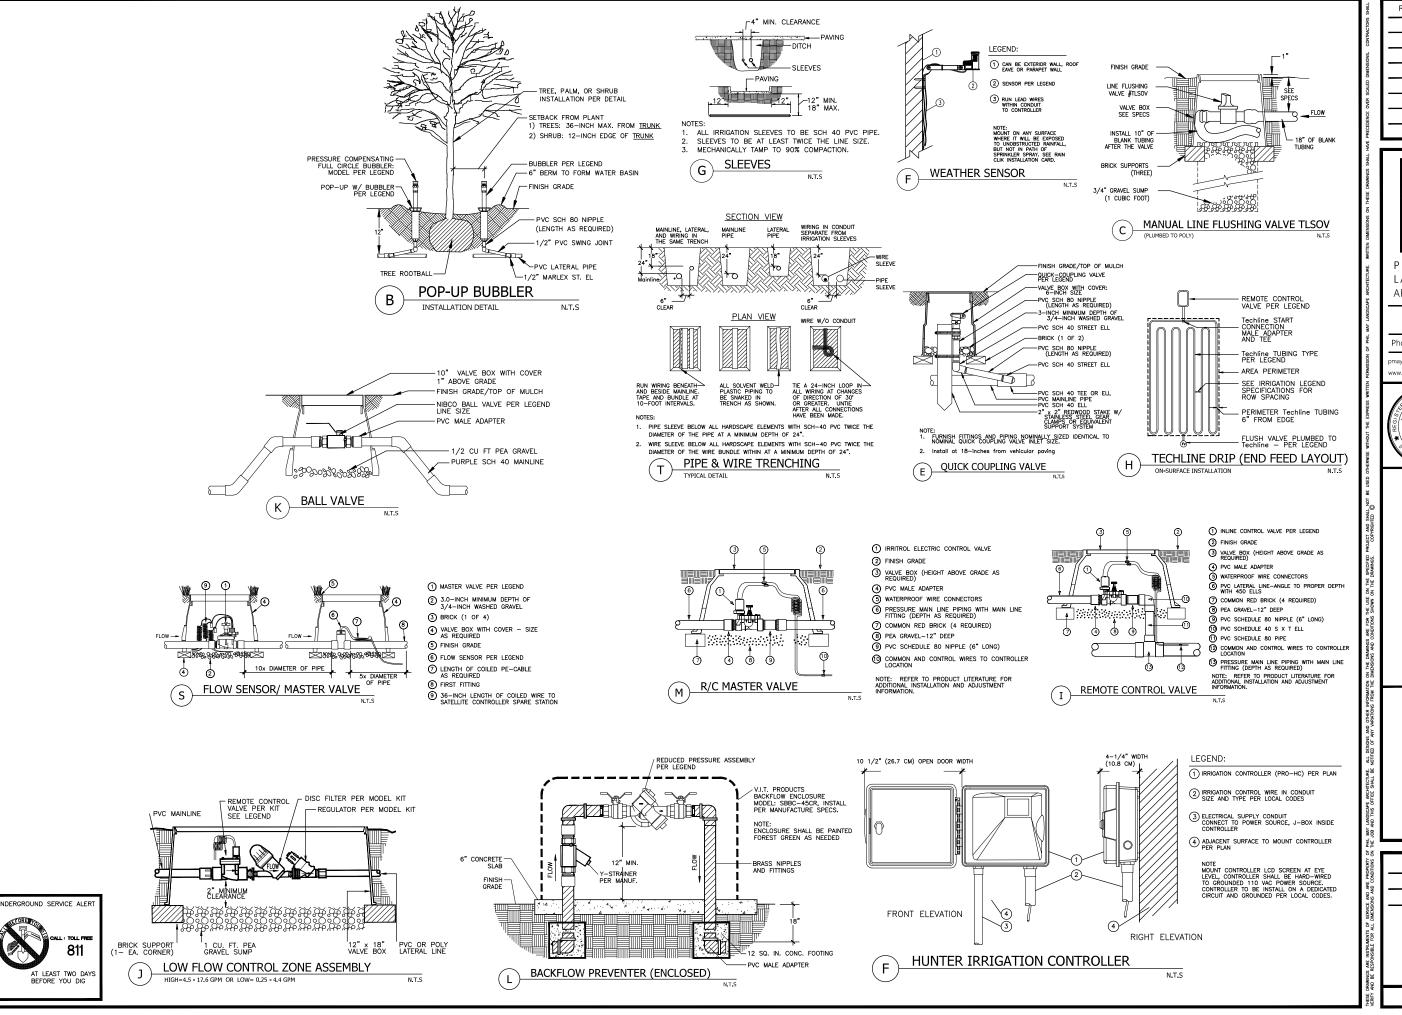



ARCHITECTURE 2532 Wallace Ave

omay@philmaydesign.com



IRRIGATION DETAILS

CA6-UNITS RESIDENTIAL DEVELOPMENT 54 MONO ST., MAMMOTH LAKES, C.

CHECKE R S DATE 06-18-2025

JOB NO. 24089